

1 PROJECT SITE PLAN
SCALE: 1 INCH = 300 FEET


- DRAFT 3/3/2021 -

SCOPE OF WORK:

PROJECT CONSTRUCTS NEW COMMUNITY PARK SITE GRADING IMPROVEMENTS AND SITE DRAINAGE PROVISIONS.

SITE DRAINAGE FROM THE ADJACENT AREAS DIRECTED ACROSS THE SITE TO SEDIMENT POND AND THROUGH POLOVINA ROAD CULVERT TO THE POND AREA BEYOND.

PROJECT IS CONTAINED WITHIN BLOCK 17, TRACT A, USS 4943 AND BLOCK 2 SEAL BEACH SUBDIVISION (ARD PLAT #2013-21).

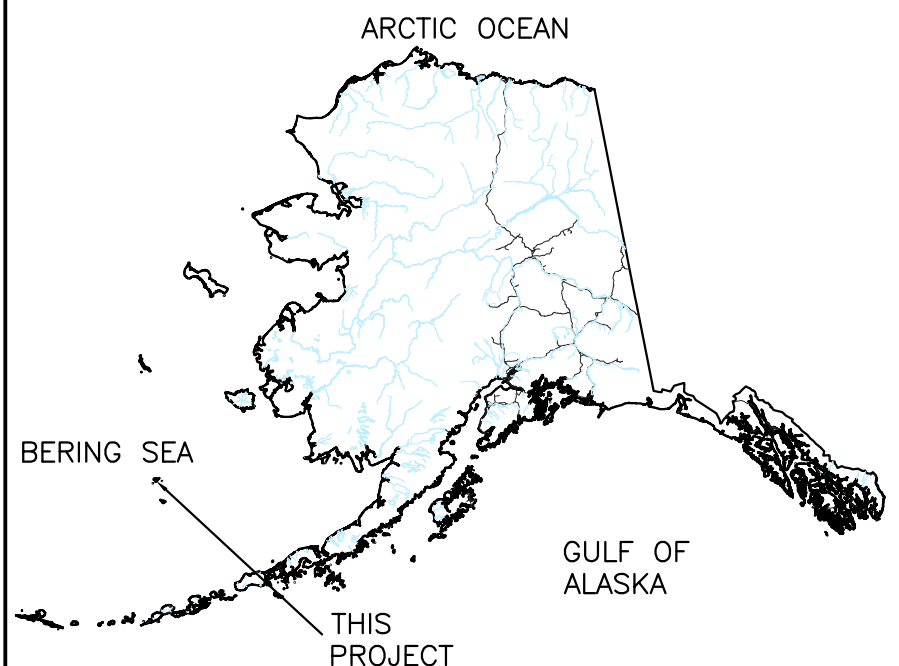

2 VICINITY MAP
SCALE: NTS

DATE: 3/3/2021
DESIGNED: MD
DRAWN: JG
CHECKED: AsNoted
SCALE: AsNoted
FILE: SnpCommPark2021

1503 WEST 33RD AVE, SUITE 310
ANCHORAGE, ALASKA 99503
PHONE (907) 258-2420
FAX (907) 258-2419

ENVIRONMENTAL SERVICES • ENGINEERING DESIGN

polarconsult alaska, inc.

DRAWING

SHEET INDEX, SITE PLAN, VICINITY MAP & QUANTITIES

PROJECT


ST. PAUL COMMUNITY PARK
BALLFIELD

ST. PAUL, ALASKA

SHEET

C-1

OF

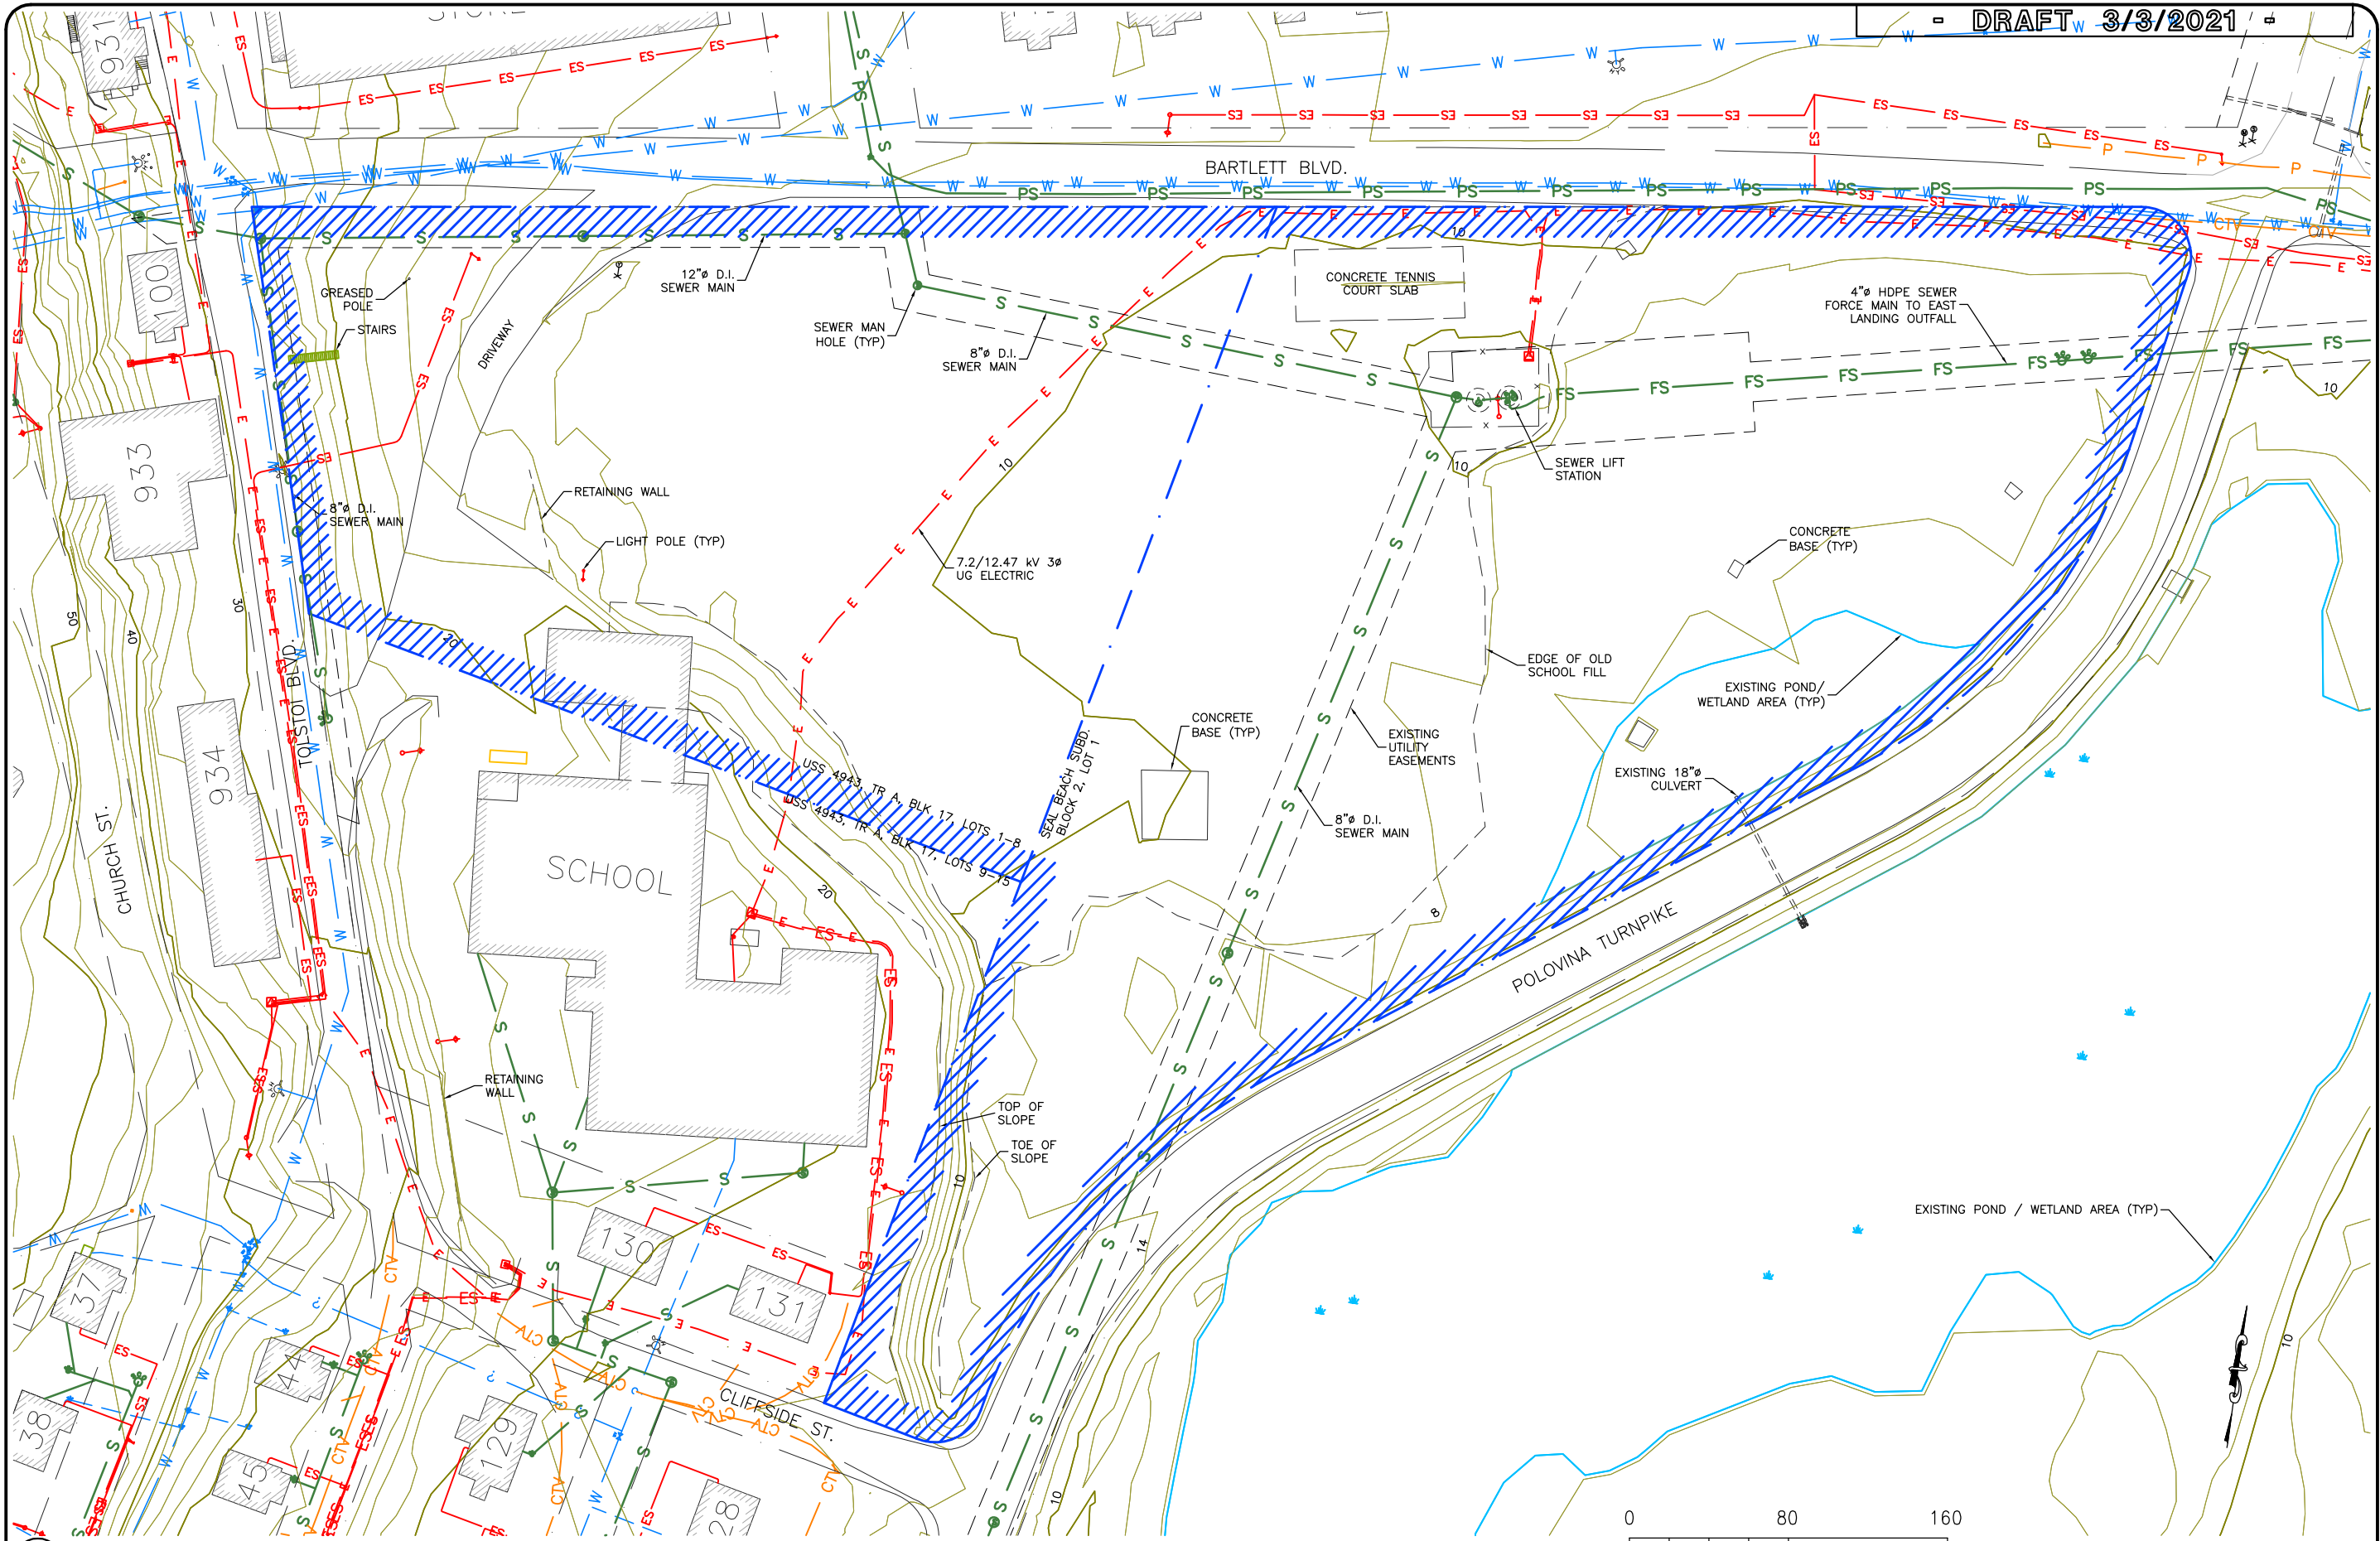

DRAFT 3/3/2021

SHEET

C-3

OF

DRAWING SITE PLAN - EXISTING CONDITIONS

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ENERGY SYSTEMS • ENVIRONMENTAL SERVICES • ENGINEERING DESIGN

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PROJECT
**ST. PAUL COMMUNITY PARK
BALLFIELD**

ST. PAUL, ALASKA

DATE: 3/3/2021

DESIGNED: MD

DRAWN: JG

CHECKED: AsNoted


SCALE: AsNoted

FILE: SNCommPark2021

1

PROJECT SITE PLAN - EXISTING CONDITIONS
SCALE: 1 INCH = 80 FEET

0 80 160
1 INCH = 80 FEET

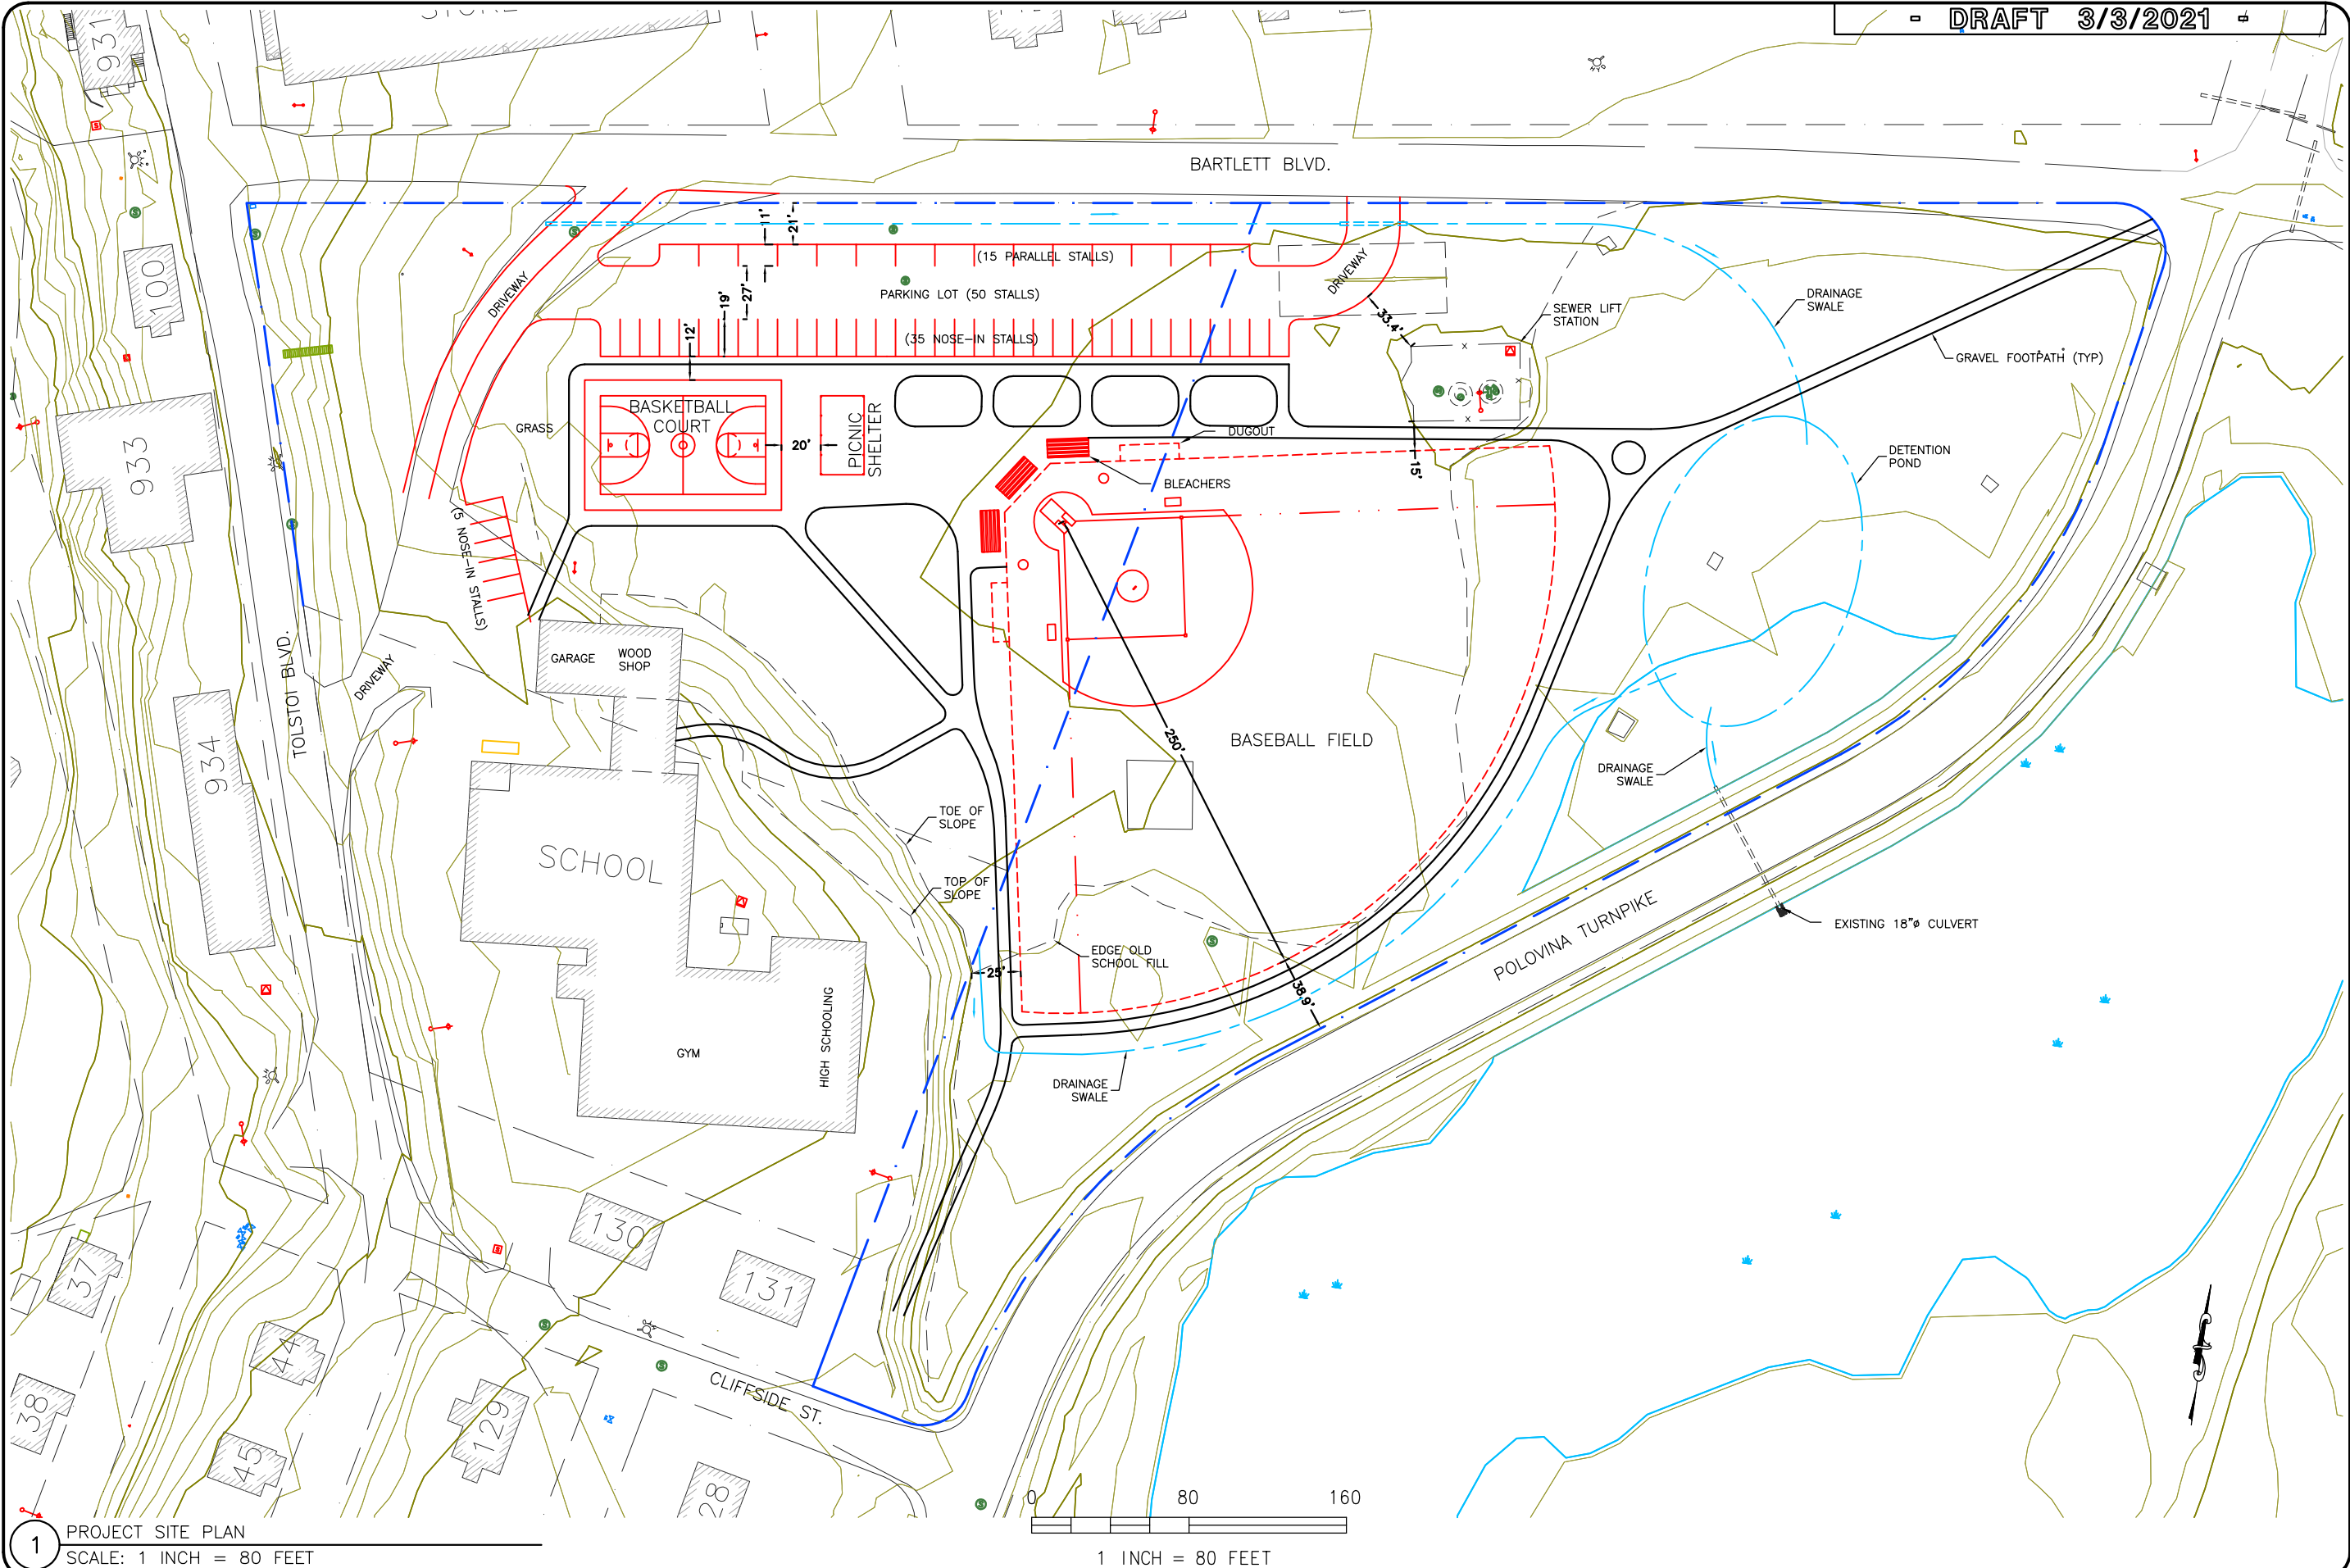

- DRAFT 3/3/2021 -

1 PROJECT SITE PLAN
SCALE: 1 INCH = 80 FEET

0 80 160
1 INCH = 80 FEET

DATE: 3/3/2021	DESIGNED: MD	DRAWN: JG	CHECKED: AsNoted	SCALE: FILE:SNPCompPark2021
DRAWING PARK SITE PLAN				
PROJECT ST. PAUL COMMUNITY PARK BALLFIELD				
SHEET C-5 OF				
ST. PAUL, ALASKA				

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